RESOLUTION NO. 30410

RESOLUTION AUTHORIZING THE LAND DEVELOPMENT OFFICE TO WAIVE THE REVIEW FEE FOR WATERWAYS, A NON-PROFIT CORPORATION, IMPROVE THE STREAM HYDROLOGY AND BUFFER ZONE AND TO PROTECT AND RESTORE WATER RESOURCES AT MOUNTAIN OR **NEAR** 4216 **CREEK** ROAD, CHATTANOOGA, TN, AS OUTLINED IN THE ATTACHED REQUEST, IN THE AMOUNT OF ONE THOUSAND THREE HUNDRED SEVENTY-FIVE DOLLARS (\$1,375.00).

BE IT RESOLVED BY THE CITY COUNCIL OF THE CITY OF CHATTANOOGA, TENNESSEE, That it is hereby authorizing the Land Development Office to waive the review fee for WaterWays, a non-profit corporation, to improve the stream hydrology and buffer zone and to protect and restore water resources at or near 4216 Mountain Creek Road, Chattanooga, TN, as outlined in the attached request, in the amount of \$1,375.00.

ADOPTED: July 7, 2020

/mem



May 14, 2020

Via Email: tkinder@chattanooga.gov

Tony Kinder, PE Site Development Manager City of Chattanooga – Land Development Office 1250 Market Street, Suite 1000 Chattanooga, TN 37402

RE: Stream Buffer Variance Request

4216 Mountain Creek Rd, Chattanooga, TN

LDP# 20-40225

Dear Mr. Kinder,

This letter is a request for the City of Chattanooga Land Development Office to consider a stream buffer variance for disturbance within the 30' & 60' water quality buffers and bank. The property located at 4216 Mountain Creek Road is 3.3-acre single family residence. Morrison Spring Creek flows from the north end of the property and connects to Mountain Creek at the southern end. The existing house is located next to Morrison Spring Creek. During flood events, the stream's water surface elevations rise above the corner of the home's foundation. The goal of this project is to reconnect the stream's floodplain and redirect the stormwater so it has more area to flood during the peak rainfall events. Thus, reducing the streams peak water surface elevations.

Roughly 580 CY of material will be removed within the stream buffer, creating a gently sloping overflow channel of less than 2%. The bank will be lowered approximately 12" at the north end and 4-6" at the southern end to reconnect the floodplain. A lot of the plant material in the buffer is invasive plants, primarily Privet. As a proposes to replant the buffer with a variety of native trees, shrubs and grasses and the landscape plan is attached. The denser vegetation will help slow down the water and stabilize the floodplain. The buffer restoration plan will also be included in the land disturbance permit (LDP #20-40225). An Aquatic Resource Alteration Permit (ARAP) has been applied for and will be included with the final submittal. Alterations to the Morrison Spring Creek will be limited to 330 ft and approximately 14,600 SF within the buffer and request a variance for this work.

If you have any questions during the review of this variance request, please do not hesitate to call.

Sincerely,

Shannon Kelly,

Shannon Kelly,

PE

Attachments:
Site Photos
C1.0 Existing Conditions
C2.0 Proposed Site & Grading Plan
C2.1 Buffer Disturbance Exhibit
CL1.0 Landscape Plan




Picture 1: View from Mountain Creek Road facing south. The stream bank at curve will be lowered approximately 12"



Picture 2: View from property's driveway facing west.



Picture 3: View from property's driveway, facing southwest

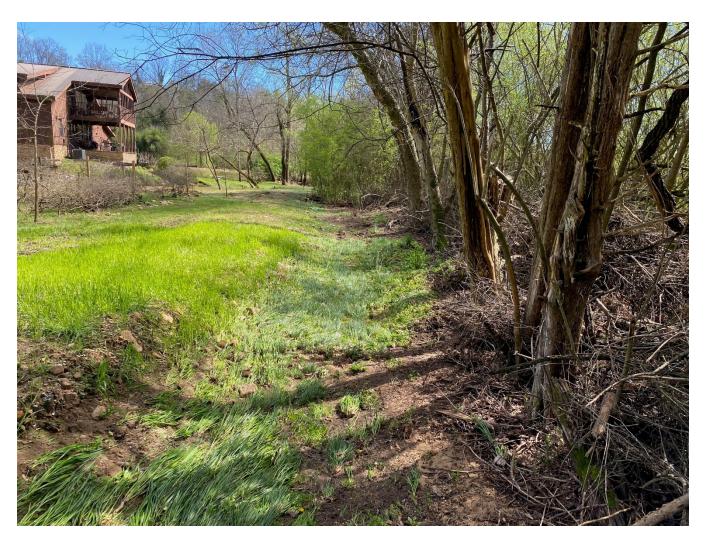


Picture 4: In front of stream bend facing south, stream is to the left. Picture's from March 25th showing the stream's natural path over the bank during larger storm events.



Picture 5: In front of stream bend facing south, to the right of picture 4 shows mostly privet and debris.



Picture 6: In front of stream bend facing north, where bank will be lowered to approximately 12"

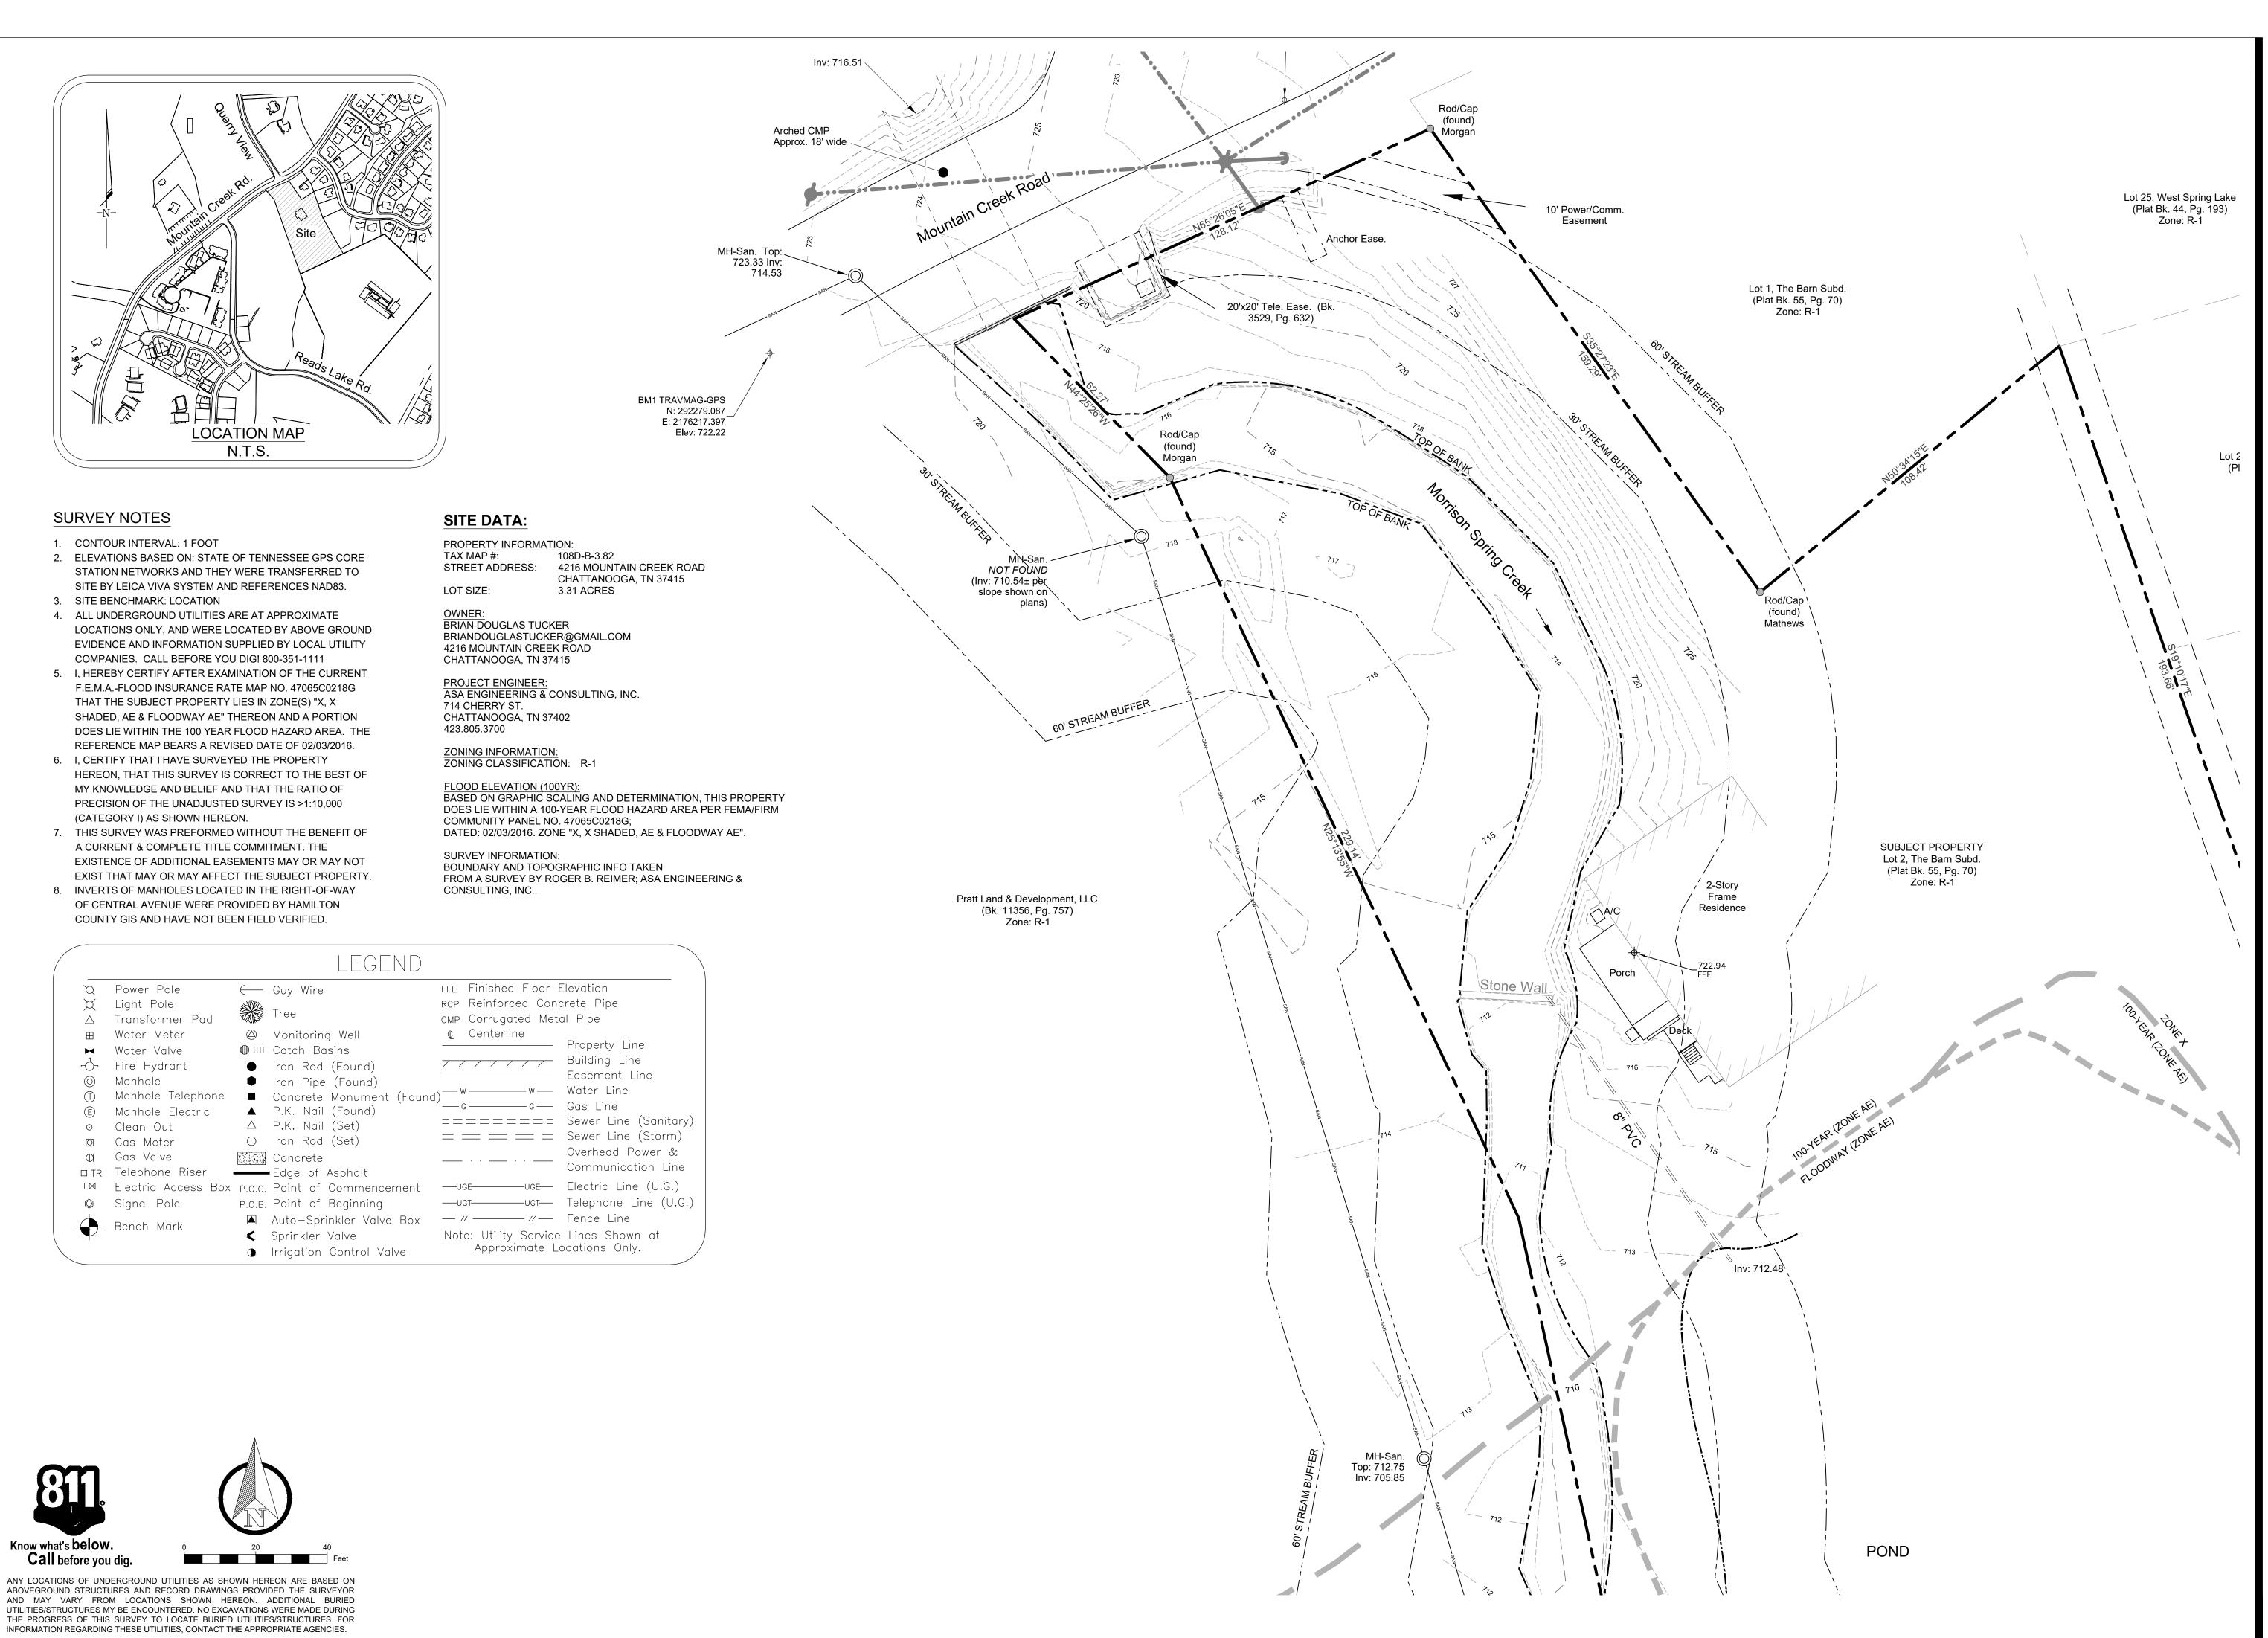

CHATTANOOGA, TN 37402 www.AsaEngineeringInc.com 423.805.3700

ISSUE FOR


PERMITTING

© 2019 Asa Engineering & Consulting, Inc.
Drawings, written material and design concepts shall not be used
or reproduced in whole or part in any form or format without prior
written consent of Asa Engineering & Consulting, Inc. PROJECT NO. 19-0213 04/24/2020 SCALE

AS SHOWN **DESIGNED BY** ASA ASA DRAWN BY CHECKED BY ASA TITLE

> **EXISTING** CONDITIONS

SHEET NO.

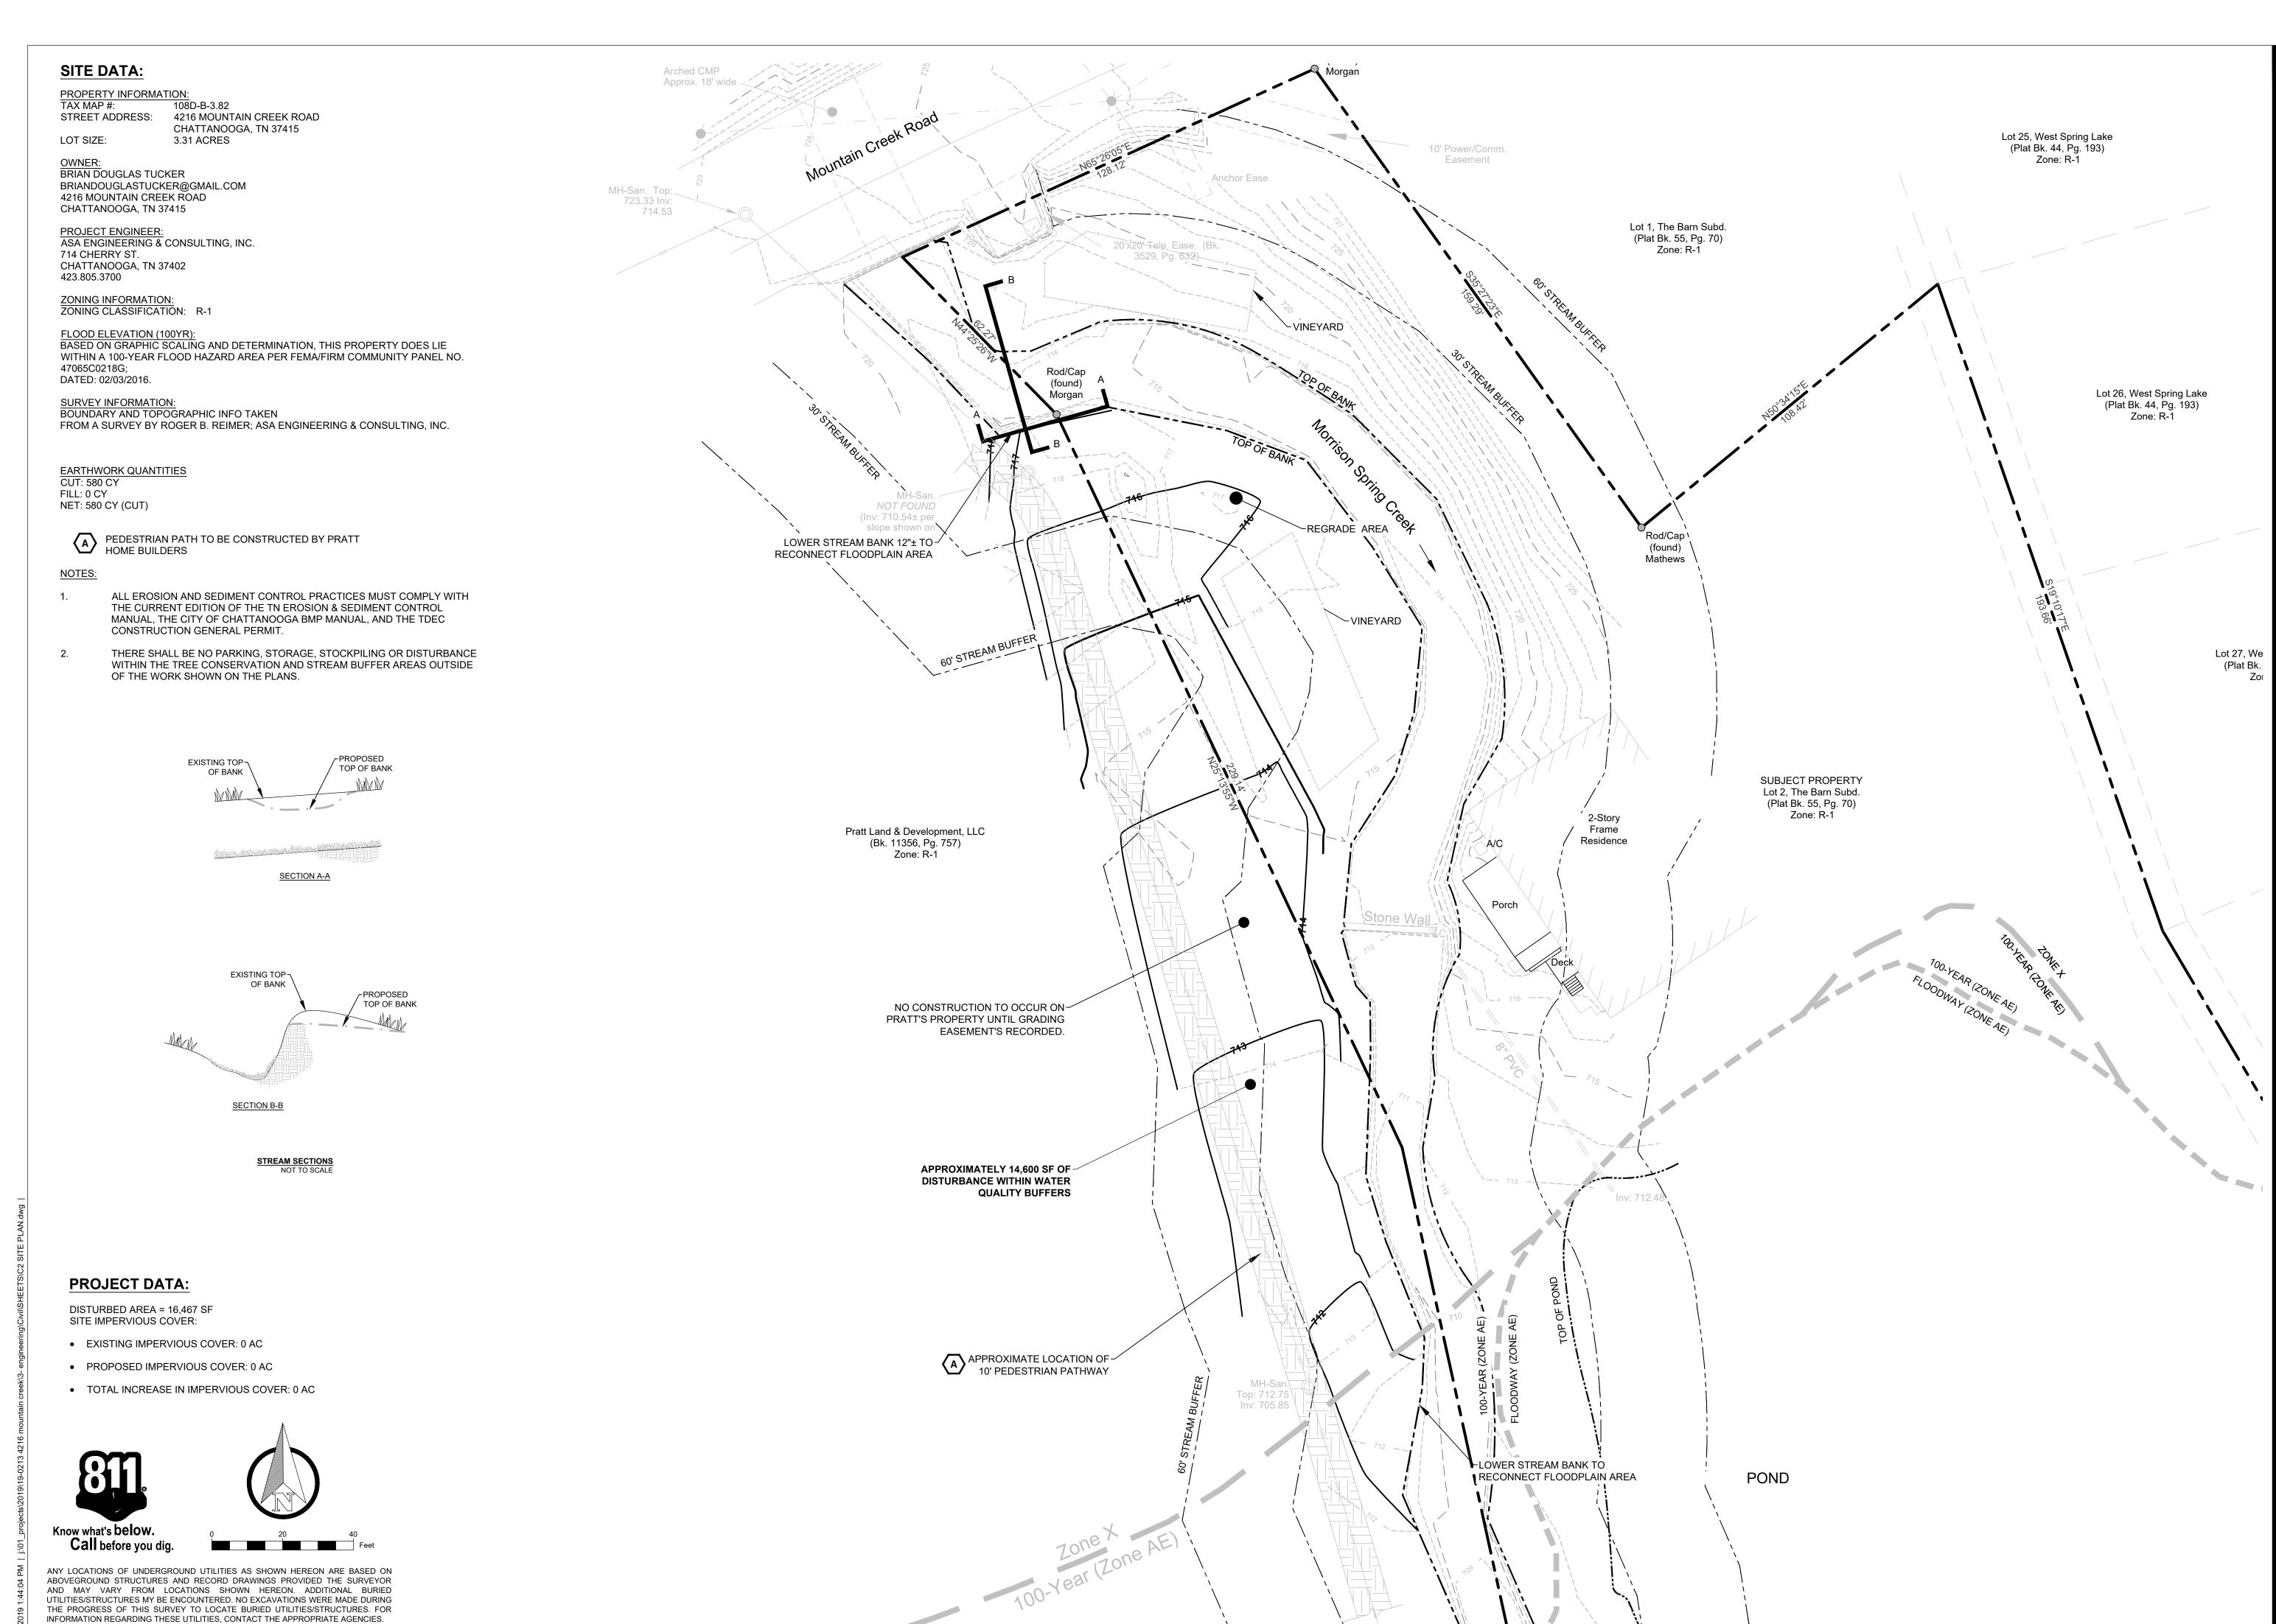

ENGINEERING & CONSULTING, INC.

714 CHERRY STREET
CHATTANOOGA, TN 37402
www.AsaEngineeringInc.com
423.805.3700

EAL

ISSUE FOR PERMITTING

ON AIN ONE EN POR FOR WATERWAYS

Asa Engineering & Consulting, Inc.
s, written material and design concepts shall not be douced in whole or part in any form or format without

© 2019 Asa Engineering & Consulting, Inc.
Drawings, written material and design concepts shall not be used or reproduced in whole or part in any form or format without prior written consent of Asa Engineering & Consulting, Inc.

PROJECT NO. 19-0213

DATE 04/24/2020
SCALE AS SHOWN
DESIGNED BY ASA
DRAWN BY ASA

ASA

SITE & GRADING PLAN

SHEET NO.

CHECKED BY

C2.0

EARTHWORK QUANTITIES CUT: 580 CY FILL: 0 CY NET: 580 CY (CUT)

NOTES:

ALL EROSION AND SEDIMENT CONTROL PRACTICES MUST COMPLY WITH THE CURRENT EDITION OF THE TN EROSION & SEDIMENT CONTROL MANUAL, THE CITY OF CHATTANOOGA BMP MANUAL, AND THE TDEC CONSTRUCTION GENERAL PERMIT.

THERE SHALL BE NO PARKING, STORAGE, STOCKPILING OR DISTURBANCE WITHIN THE TREE CONSERVATION AND STREAM BUFFER AREAS OUTSIDE OF THE WORK SHOWN ON THE PLANS.


Arched CMP Approx. 18' wide Lot 25, West Spring Lake (Plat Bk. 44, Pg. 193) Zone: R-1 10' Power/Comm Easement MH-San. Top: 723.33 Inv: 714.53 Lot 1, The Barn Subd. (Plat Bk. 55, Pg. 70) Zone: R-1 20'x20' Tele. Ease. (Bk Lot 26, West Spring Lake (Plat Bk. 44, Pg. 193) Zone: R-1 NOT FOUND (Inv: 710.54± per slope shown on Rod/Cap \ (found) Mathews Lot 27, We (Plat Bk. SUBJECT PROPERTY Lot 2, The Barn Subd. (Plat Bk. 55, Pg. 70) Zone: R-1 2-Story Pratt Land & Development, LLC (Bk. 11356, Pg. 757) Zone: R-1 Frame Residence APPROXIMATELY 14,600 SF OF DISTURBANCE WITHIN WATER **QUALITY BUFFERS** POND

PROJECT DATA:

DISTURBED AREA = 16,467 SF SITE IMPERVIOUS COVER:

- EXISTING IMPERVIOUS COVER: 0 AC
- PROPOSED IMPERVIOUS COVER: 0 AC
- TOTAL INCREASE IN IMPERVIOUS COVER: 0 AC



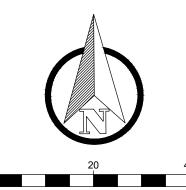

ANY LOCATIONS OF UNDERGROUND UTILITIES AS SHOWN HEREON ARE BASED ON ABOVEGROUND STRUCTURES AND RECORD DRAWINGS PROVIDED THE SURVEYOR AND MAY VARY FROM LOCATIONS SHOWN HEREON. ADDITIONAL BURIED UTILITIES/STRUCTURES MY BE ENCOUNTERED. NO EXCAVATIONS WERE MADE DURING THE PROGRESS OF THIS SURVEY TO LOCATE BURIED UTILITIES/STRUCTURES. FOR INFORMATION REGARDING THESE UTILITIES, CONTACT THE APPROPRIATE AGENCIES.

C2.1

BUFFER DISTURBANCE

EXHIBIT

© 2019 Asa Engineering & Consulting, Inc.
Drawings, written material and design concepts shall not be used
or reproduced in whole or part in any form or format without prior
written consent of Asa Engineering & Consulting, Inc.

19-0213

04/24/2020

AS SHOWN

ASA

PROJECT NO.

DESIGNED BY

DRAWN BY

CHECKED BY

SHEET NO.

SCALE

714 CHERRY STREET

CHATTANOOGA, TN 37402 www.AsaEngineeringInc.com 423.805.3700

ISSUE FOR

PERMITTING



ENGINEERING & CONSULTING, INC.

714 CHERRY STREET
CHATTANOOGA, TN 37402
www.AsaEngineeringInc.com
423.805.3700

EAL

ISSUE FOR PERMITTING

 \cap

MOUNIAIN CKEEF

9 Asa Engineering & Consulting, Inc.

© 2019 Asa Engineering & Consulting, Inc.
Drawings, written material and design concepts shall not be used or reproduced in whole or part in any form or format without prior written consent of Asa Engineering & Consulting, Inc.

PROJECT NO. 19-0213

DATE 04/24/2020

SCALE AS SHOWN
DESIGNED BY ASA
DRAWN BY ASA
CHECKED BY ASA
TITLE

LANDSCAPE PLAN

SHEET NO.

L1.0